

MADERA UNIFIED SCHOOL DISTRICT PARKWOOD ELEMENTARY SCHOOL KITCHEN

1150 E PECAN AVENUE, MADERA, CA 93637

GENERAL

PROJECT DESCRIPTION

PLUMBING REMODEL TO ACCOMMODATE NEW OVENS INCLUDING THE DEMOLITION OF EXISTING CURBS AND ADDITION OF NEW FLOOR SINK.

MECHANICAL ENGINEER OF RECORD

NET POSITIVE CONSULTING ENGINEERS

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SITE MAP



PLUMBING SCHEDULE

MARK	FIXTURE	CONNECTION SIZES				DESCRIPTION
MAKK		SorW	V	CW	HW	DESCRIPTION
<u>FS-1</u>	FLOOR SINK	r	1-1/2*	TP	-	J.R SMITH MODEL #3150-Y, COATED CAST IRON, ACID RESISTANT PAINTED INTERIOR, 12-1/2" SQUARE TOP, 8" DEEP, DOUBLE DRAINAGE FLANGE, NO HUB OUTLET & DOME STRAINER.
<u>TP-1</u>	TRAP PRIMER	н	-	3/4"	-	PRECISION PLUMBING PRODUCTS "PRIME-RITE" MODEL #PR-600 PRESSURE DROP ACTIVATED WITH FOULU INSTRIBUTION UNIT FOR UP TO (2) DARIES. PROVIDE 14"x14" STAINLESS STEEL ACCESS DOOR WITH CYLINDER LOCK. PROVIDE SOV UP STREAM OF TRAP PRIMER.
<u>TD-1</u>	TRENCH DRAIN	4"	1-1/2"	-	-	ACO POWERDRAIN STOKK 4" DRAIN SYSTEM WITH 4" THROAT, CLASS F VENICLE RATRIG, LENGTH PER PLAN WITH 0.5% SLOPE BUILD-IN, HOPE TERRICH DAULH SYSTEM WITH FOLLYROPYLENE HEEL-PROOF ADA COMPLIANT 20" LONG SLOTTED GRAIT, CLOSED BID CAP, AND 4" NO-HUB BOTTOM

SHEET INDEX

COVER SHEET PLUMBING SPECIFICATIONS AND DETAILS

GOVERNING CODES

2022 CALIFORNIA ADMINISTRATIVE CODE (CAC), C.C.R. TITLE 24, PART 1
2022 CALIFORNIA BUILDING CODE (CBC), C.C.R. TITLE 24, PART 2
2022 CALIFORNIA MECHANICAL CODE (CEC), C.C.R. TITLE 24, PART 3
2022 CALIFORNIA MECHANICAL CODE (CMC), C.C.R. TITLE 24, PART 4
2022 CALIFORNIA FUNMBING CODE (CPC), C.C.R. TITLE 24, PART 5
2022 CALIFORNIA FIRE CODE (CFC), C.C.R. TITLE 24, PART 5
2022 CALIFORNIA FIRE CODE (CFC), C.C.R. TITLE 24, PART 12
2022 CALIFORNIA ENERGY CODE (CAC), C.C.R. TITLE 24, PART 1
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2022 CAL

GENERAL NOTES

- COORDINATION OF WORK: LAYOUT OF MATERIALS, EQUIPMENT AND SYSTEMS IS GENERALLY DIAGRAMMATIC UNLESS SPECIFICALLY DIVENSIONED, SOME WORK MAY BE SHOWN OFFSET FOR CLARITY.
- THE ACTUAL LOCATION OF ALL MATERIALS, PIPING, DUCTWORK, FIXTURES, EQUIPMENT, SUPPORTS, ETC. SHALL BE CAREFULLY PLAY

- 6. MINIMUM SLOPE FOR SEWER IS 1/4" PER FT, UNLESS OTHERWISE NOTED
- ALL ROOF PENETRATIONS SHALL BE COMPATIBLE WITH ROOF SYSTEM WITH AS FEW PENETRATIONS AS POSSIBLE.
- MINIMUM DOMESTIC WATER PIPE SIZE TO BE 3/4", USE A REDUCING ELL AT FIXTURE, IF NECESSARY.

PLUMBING LEGEND

SYMBOL	ITEM	ABBR.
	ABOVE	ABV
	ABOVE CEILING	ABV CLG
	ABOVE FINISHED FLOCR	AFF
8	ALTERNATE	ALT
- 6	ARCHITECT / ARCHITECTURAL	ARCH
@	AT	
	BELOWFLOOR	BEL FLR
	BELOW GRADE	BEL GR
	CALIFORNIA MECHANICAL CODE	СМС
	CALIFORNIA PLUMBING CODE	CPC
	CEILING	CLG
5	CENTER LINE CONTINUATION	CONT
	CUBIC FEET PER HOUR	CFH
Ø	DIAMETER	DIA
	DOWN	DN
	DRAWING	DWG
	ELBOW	ELL
	ELECTRICAL	ELEC
	EXISTING	(E)
	FEET	FT FLR
	FLOOR FLOW LINE	FL
	GALLON	GAL
	GALLONS PER HOUR	GPH
	GALLONS PER MINUTE	GPM
	GAUGE	GA
	INSIDE DIAMETER	ID
	INVERT ELEVATION	LE.
	MUMIXAM	MAX
	MENANN	WM
	NEW NOT IN CONTRACT	(N)
	NOT TO SCALE	NTS
#	NUMBER	NO.
	OWNER FURNISHED OWNER INSTALLED	OFOI
	POUNDS	LBS
	POUNDS PER SQUARE INCH	PSI
	POUNDS PER SQUARE INCH ABSOLUTE	PSIA
	POUNDS PER SQUARE INCH GAUGE	PSIG
	POLYVINYL CHLORIDE ROOM	PVC RM
	SPECIFICATION	SPEC
	SQUARE FEET	SQFT
	STAPILESS STEEL	ss
	TEMPERATURE	TEMP
	THROUGH	THRU
	TYPICAL	(TYP)
	UNDER GROUND	urg
	WATER COLUMN	WC
	WITH	W
	WITHOUT	W/O
A	COVPRESSED AIR	Α
— AV —	ACID VENT ACID WASTE	VA WA
0	ACID VENT RISER	AVR
0	ACID VENT THRU ROOF	AVTR
—со—	CONDENSATE DRAIN	CD
	DOMESTIC COLD WATER	cw
	DOMESTIC HOT WATER	HW
	DOMESTIC HOT WATER RETURN	HWR
—-G—	LOW PRESSURE NATURAL GAS	G
—HPG—	HIGH PRESSURE GAS	HPG
—ICW—	INDUSTRIAL COLD WATER LIQUIFIED PETROLEUM GAS	LPG
—-F—	FIRE PROTECTION LINE	
		RWL
-RWL	RAIN WATER LEADER	
—RWL—	RAIN WATER LEADER OVERFLOW DRAIN	OD
		_
	OVERFLOW DRAIN STORM DRAIN SCIL OF WASTE	00
	OVERFLOW DRAIN STORM DRAIN SOIL OF WASTE MEDICAL AIR	SD S or W MA
	OVERFLOW DRAIN STORM DRAIN SOLL OF WASTE MEDICAL AIR OXYGEN	SD S or W MA O ₂
	OVERFLOW DRAIN STORM DRAIN SOLL OF WASTE WEDICAL AIR OXYGEN VACUUM	SD S or W MA O ₂ VAC
— SD — SD — MA — O2 — VAC — — VAC — — — — — — — — — — — — — — — — — — —	OVERFLOW DRAIN STORM DRAIN SOL or WASTE MEDICAL AIR OXYGEN VACUUM VENT	SD S or W MA O2 VAC V
	OVERFLOW DRAIN STORM DRAIN SOCIA OF VIASTE MEDICAL AIR OXIGER VACUUM VEHT VEHT RISER	SD S or W MA O ₂ VAC
— SD — SD — MA — O2 — VAC — — VAC — — — — — — — — — — — — — — — — — — —	OVERFLOW DRAIN STORM DRAIN SOL or WASTE MEDICAL AIR OXYGEN VACUUM VENT	OD SD S or W MA O ₂ VAC V VR
— SD — MA — O2 — YAC — O	OVERFLOW DRAIN STORM DRAIN SOLL OF WASTE MEDICAL AIR OXYGEN VACUUM VENT VENT RISER VENT THRU ROOF	OD SD S or W MA O ₂ VAC V VR VTR
— SD — SD — MA — O2 — YAC — O O — Ф	OVERFLOW DRAIN STORM DRAIN SOL & WASTE WEDICAL AIR OXYGEN VACUUM VEHT VEHT RISER VEHT THRU ROOF CLEANOUT TO GRADE	OD SD S or W MA O2 VAC V VR VTR COTG
— SD — SD — MA — O2 — YAC — O O — Ф	OVERFLOW DRAIN STORM DRAIN SOCIA OVERSTE MEDICAL AIR OXIGEN VACUUM VEHT VEHT RISER VEHT TIRGU ROOF CLEANOUT TO GRADE DENOLITION	OD SD S or W MA O2 VAC V VR VTR COTG
— 00— s0— s0—	OVERFLOW DRAIN STORM DRAIN SOL & WASTE MEDICAL AIR OXYGEN VACUUM VEHT VEHT THERE VEHT THERE CLEANOUT TO GRADE DEWOLITION ELISTING PIPMO FLOOR CLEANOUT HOSE BIBB	OD SD SD SD SD VAC VAC V VR VTR COTG DEMO
	OVERFLOW DRAIN STORM DRAIN STORM DRAIN SOL OF WASTE MEDICAL AIR OXIGER VACUUM VEHT VEHT RISER VEHT THRU ROOF CLEANOUT TO GRADE DEVOLITION EXISTING PIPPIG FLOR CLEANOUT HOSE RISB PPPIG TURN UP	OD SD SerW MA O2 VAC VR VTR COTG DEMO
	OVERFLOW DRAIN STORM DRAIN STORM DRAIN SOLG OF WASTE MEDICAL AIR OXIGEN VACUUM VEHT VEHT RISER VEHT THRU ROCE CLENOUT TO GRADE DEMOLITION EXISTING PIPPING FLOOR CLENOUT HOSE BIBB FPPING TURL UP FPERG TURL UP FPERG TURL I	OD SD SD SD SD VAC VAC V VR VTR COTG DEMO
- CD	OVERFLOW DRAIN STORM DRAIN STORM DRAIN SOL OF WASTE MEDICAL AIR OXYGEN VACUUM VENT VENT RISER VENT THRU ROOF CLEANOUT TO GRADE DEMOLITION EXISTING PIPPIG FLOOR CLEANOUT HOSE BIBB PIPPIG TURN UP FIPPIG TURN UP FIPPIG TOWN	OD SD SerW MA O2 VAC VR VTR COTG DEMO
- CO	OVERFLOW DRAIN STORM DRAIN STORM DRAIN SOL OF WASTE MEDICAL AIR OXIGER VACUUM VEHT VEHT RISER VEHT THRU ROOF CLEANOUT TO GRADE DEMOLITION EXISTING PIPPIG FLOOR CLEANOUT HOSE BIBB PEPEN TURN UP FIPPIG TURN UP FIPPIG TOP CONNECTION TO BUSTERS	OD SD SerW MA O2 VAC VR VTR COTG DEMO
	OVERFLOW DRAIN STORM DRAIN STORM DRAIN SOL OF WASTE MEDICAL AIR OXYGEN VACUUM VENT VENT RISER VENT THRU ROOF CLEANOUT TO GRADE DEMOLITION EXISTING PIPPIG FLOOR CLEANOUT HOSE BIBB PIPPIG TURN UP FIPPIG TURN UP FIPPIG TOWN	OD SD SerW MA O2 VAC VR VTR COTG DEMO
	OVERFLOW DRAIN STORM DRAIN STORM DRAIN SOL OF WASTE MEDICAL AIR OXIGER VACUUM VEHT VEHT RISER VEHT THRU ROOF CLEANOUT TO GRADE DEMOLITION EXISTING PIPPIG FLOOR CLEANOUT HOSE BIBB PEPEN TURN UP FIPPIG TURN UP FIPPIG TOP CONNECTION TO BUSTERS	OD SD SerW MA O2 VAC VR VTR COTG DEMO
- CD - SD	OVERFLOW DRAIN STORM DRAIN STORM DRAIN SOL OF WASTE MEDICAL AIR OXIGER VACUUM VEHT VEHT RISER VEHT THRU ROOF CLEANOUT TO GRADE DEMOLITION EXISTING PIPING FLOOR CLEANOUT HOSE BIBB PEPENT TURN UP FIPING TURN UP FIPING TO CONNECTION TO EXISTING ANGLE VALVE	OD SD SerW MA O2 VAC VR VTR COTG DEMO

SYMBOL	ITEM	ABB			
— →	CONCENTRIC REDUCER				
—&—	TWO-WAY CONTROL VALVE				
-	PLUG VALVE				
—₺—	PRESSURE REDUCING VALVE				
—⊗—	SHUT-OFF VALVE IN BOX	SOV			
$-\bowtie$	SHUT-OFF VALVE	sov			
M	THERMOSTATIC MIXING VALVE				
7	TEMPERATURE / PRESSURE RELIEF VALVE	PRV			
 	UNION				
-11	→I WALL CLEANOUT				
	"Y" TYPE STRAINER				
Ø	PRESSURE GAUGE				
O	TEMPERATURE GAUGE				
1	KEYNOTE				
WC-1	NEW FIXTURE TAG EXAMPLE WATER CLOSET - TYPE 1 (REFER TO PLUMBING SCHEDULE)				
2 Pê00	DETAIL REFERENCE EXAMPLE: DETAIL 2, SHEET P&00				
3 P300	SECTION REFERENCE EXAMPLE: SECTION 3, SHEET P300				

ANCHORAGE & BRACING NOTES

FIPINS, DUGTWORK, AND ELECTRICAL DISTRIBUTION SYSTEMS SHALL BE BRACED TO COMPLY WITH THE FORCES AND DISPACEMENTS PRESCRIBED IN ASCE 7-16 SECTION 13.3 AS DEFINED IN ASCE 7-16 SECTION 13.4 S. 18.6, 13.67, 13.8,8, AND 2019 CBC, SECTION 1617A.1.24, 1617A.1.25 AND 1617A.1.26.

MECHANICAL PIPING (MP), MECHANICAL DUCTS (MD), PLUMBING PIPING (PP), ELECTRICAL DISTRIBUTION SYSTEMS (E):

MADERA COUNTY ENVIRONMENTAL HEALTH DIVISION

Madera County
Wironmental Health Department
APPROVED

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USD S KITCHEN MADERA US PARKWOOD ES N

COVER SHEET

P001

PLUMBING SPECIFICATIONS

GENERAL MECHANICAL SPECIFICATIONS
CONTRACTOR SHALL PROVIDE A COMPLETE WORKING SYSTEM AND SHALL INCLUDE ALL ACCESSORIES, PARTS, WATERIALS AND LABOR REQUIRED TO MEET FERFORMANCE CAPACITY. AND QUALITY REQUIREDING OF CONTRACT DOCUMENTS.

- 1, <u>COCES AND REQUILATIONS</u> ALL WORK AND MATERIALS SHALL BE IN ACCORDANCE WITH THE FOLLOWING CODES AS ADOPTED AND AVERAGED BY THE AUTHORITY HAVING JURISOCITION, NOTHEND IN THESE DRAWINGS OR SPECIFICATIONS IS TO BE CONSTRUED TO PERMIT WORK NOT CONCENUES TO THESE CODES.

- FERMITS INSPECTIONS AND SERVICE CONNECTION CHARGES OGTANIALL PERMITS REQUIRED FOR PERFORMING WORK AND PAY ALL RELATED FEES. PAY ALL CHARGES FOR SERVICE CONNECTIONS, METERS, ETC. BY UTILITY COMPANIES OR DISTRICTS, GALL FOR ALL REQUIRED INSPECTIONS AND PAY ALL RELATED FEES.
- 3. WORK BY OTHERS, UNLESS OTHERWISE NOTED, THE ELECTRICAL CONTRACTOR SHALL PROVIDE ALL POWER WIRING, MOTOR STARTERS IN MOTOR CONTROL CENTERS, DISCONNECTS, CONTROL WIRING AND CONDUIT AND INSTALLATION OF CONTROL DEVICES.
- 4. <u>QUARMITTE</u> THE CONTRACTOR SHALL REPAIR ANY DEFECTS DUE TO FAULTY MATERIALS OR WORKMANSHIP AND PAY FOR ANY DAVAGE TO DITHER WORK RESULTING THEREFROM WHICH APPEARS WITHIN A PERIOD OF ONE YEAR FROM DATE OF ACCEPTANCE OF WORK.
- 5. OPERATING AND MAINTENANCE INSTRUCTIONS: TWO COPIES OF ALL EQUIPMENT OPERATION AND MAINTENANCE INSTRUCTIONS AND WIRING DIAGRAMS SHALL BE FURNISHED TO THE OWNER, THROUGH THE ENGINEER.
- 6. MATERIALS COMPARITAND RISTALLATION, EACH ITEM REPERRED TO ON THE DRAWINGS AND IN THE SPECIFICATIONS REPRESENTS THE STREAMS OF QUALITY DESIRED FOR MATERIALS, EQUIPMENT AND INSTALLATION, CONTRACTOR SHALL PROVIDE A RESUMMITAL THAN ONE RESUMMENTAL IS REQUIRED BY THE ENTINEER. THE CONTRACTOR SHALL EACH THE COST OF THE ENTINEERS REVIEW OF A THAN ONE RESUMMENTAL IS REQUIRED BY THE ENTINEER. THE CONTRACTOR SHALL EACH THE COST OF THE ENTINEERS REVIEW OF A THAN ONE RESUMMENTAL IS REQUIRED BY THE ENTINEER THE CONTRACTOR SHALL EACH THE COST OF THE ENTINEERS REVIEW OF THE PROVIDED BY THE MANAFED REPORT OF THE REPORT OF THE PROVIDED BY THE MANAFED BY THE PROVIDED BY T
- 8. <u>PIPES PASSING THROUGH FIRE RATED SURFACES.</u> PIPES PASSING THROUGH FIRE RATED WALLS, FLOORS, CEILINGS, PARTITIONS, ETC. SHALL HAVE THE ANAMAR SPACE SURROUNDING THE FIPE OR PIPE INSULATION SEALED WITH FIRE RATED MATERIALS IN ACCORDANCE WITH THE REFULISHEFUR FLOOR FIRE FIRE AUTHORITY HAVING, IN INSURCICION.


PLUMBING SPECIFICATIONS

- UNDERGROUND PIPING ALL FERROUS PIPING BELOW GRADE (EXCEPT CAST IRON) SHALL HAVE FROTECTIVE COATING OF "X-TRU-COAT". MINIMUM COVER FOR ALL BELOW GRADE PIPING SHALL BE 24".
- 4. PIPNS MATERIALS, PROVIDE NEW MATERIALS AS SPECIFIED, ALL PIPNS MATERIALS SHALL BE COMPATIBLE WITH EXISTING FIPING MATERIAL. PROVIDE CONNECTIONS UTILIZING DIELECTRIC UNIONS BY EPCO OR BRASS NIPPLES WITH MINMUM LENGTH OF 4 INCHES WHEN COMMISCITING FERROLDS TO INDEPENDENT PIPNS.
- A. DOMESTIC WATER HARD TEMPER SEAMLESS COPPER, ASTM B88, BRAZED JOINTS
 B. GAS BLACK STEEL ASTM A120
 C. SCIL, WASTE & VEHT CAST IRON, CISF1 301
 D. CONCENSATE DRAIN HARD TEMPER SEAMLESS COPPER, ASTM B88, BRAZED JOINTS

- A. FIPE HANGER, STEEL "J" HANGER WITH SIDE BOLT, PROVIDE ISOLATING SHIELD ON INSULATED PIPE, GALVANIZED STEEL AND REINFORCING RIBS WITH 1/4" NON-CONDUCTING HAIR FELT PAD.
- PIPE SIZE MAX SPACING
 1/2" 1-1/2" 6'-0"
 2" 6" 10'-0"
- 6. <u>INSULATION</u> ALL HOT WATER PIPING TO BE INSULATED, WRAP ALL FITTINGS AND VALVES WITH PRE-CUT FIBERGLASS BLANKET TO THICKNESS MATCHING ADJOINING INSULATION. ALL INSULATION AND BLANKETS TO BE COVERED WITH PVC JACKET, SOLVENT WELD.
- 7. <u>VALVES</u>. SIZE 2" AND SMALLER: RISING STEM, UNION BONNET ALL BRONZE, WEDGE DISC, 125 WSP, STOCKHAM B-105. SIZE 2-1/2" AND LARGER: IRON BODY, BRONZE MOUNTED NON-RISING STEM, FLANGED 125 WSP, STOCKHAM G-612.
- 8. <u>PIPE INSULATION (MAXIMUM THERMAL CONDUCTIVITY 0.23 BTU-NWHR-FT2-F)</u> INSULATE HOT WATER FIPING WITH 1"THICK FIBERGLASS WITH ALL SERVICE JACKET.
- 9. FIXTURES: ALL FIXTURES SHALL BE WHITE UNLESS OTHERWISE NOTED, ALL FIXTURES SHALL BE FURNISHED AND INSTALLED COVERETE WHIT THIS, SEALS, CARRIERS, STOPS, ADA PROTECTIVE INSULATION, ETC. FIXTURE HEIGHT AND LOCATION AS INDICATED ON THE ARCHITECTURAL DRAWINDS, PROVIDE PROFER SEAKING, AND HANGER FLATES FOR WILL-HUMG STRUMES.
- 10. TESTS AND DISINFECTION: FERFORM ALL TESTS AND DISINFECTION AS REQUIRED BY APPLICABLE CODES IN PRESENCE OF PLUMBING INSPECTOR.



PLUMBING DETAILS

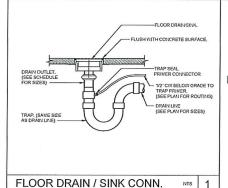

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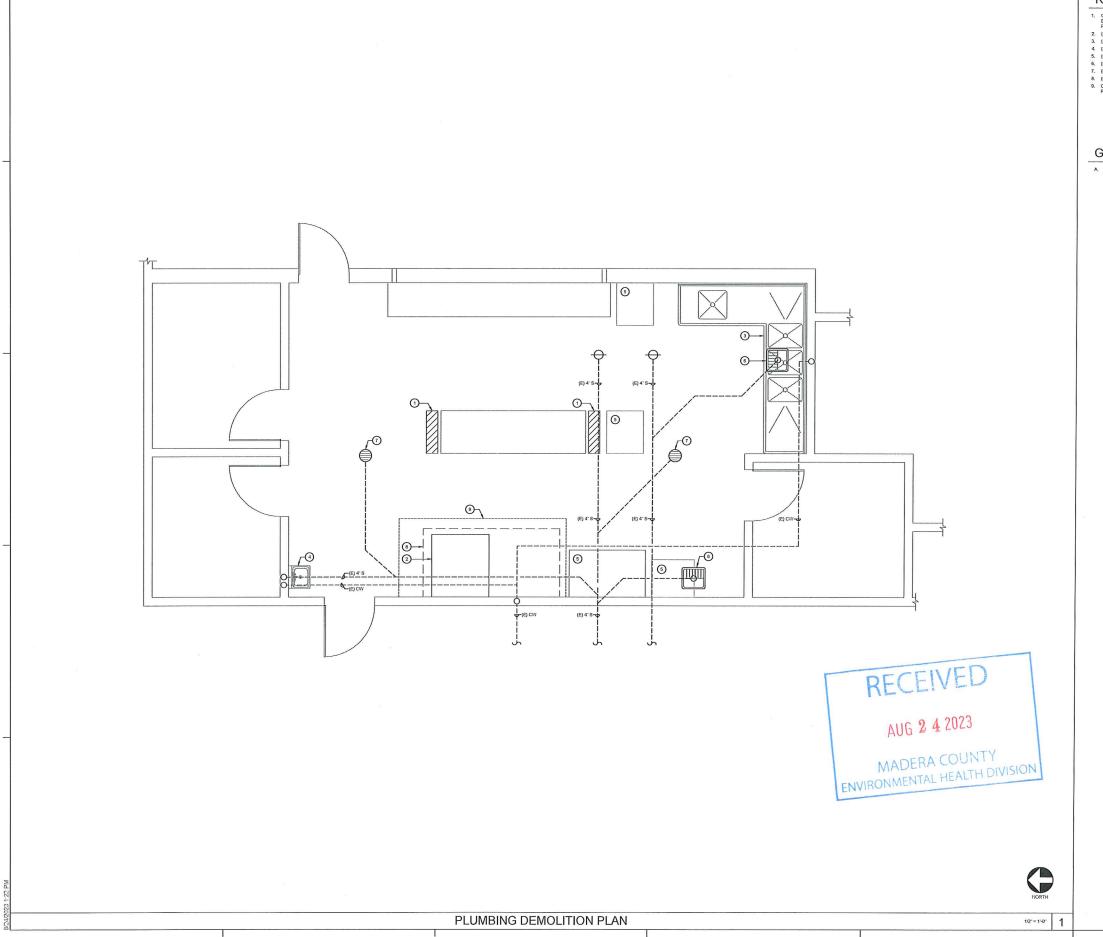
The ideas, drawings, designs and specifications incorporated herein serve as an instrument of services ancient services and consulting Engineers, Inc. and is not be copied, reproduced, or distributed without the written authorization of Net Postive Consulting Engineers, Inc.



REVISIONS: Symbol Description

USD S KITCHEN MADERA US PARKWOOD ES K

DATE: 07/18/2023 HEET TITLE: PLUMBING SPECIFICATIONS AND **DETAILS** HEET NO: P002



KEYNOTES ⊕

- 1. OUT (E) CONCRETE SLAB ON GRADE TO RENOVE (E) CURB AND ELECTRICAL OUTLET, REMOVE ELECTRICAL WIRE BACK TO PANEL, REMOVE BEAKER, AND SAECHOFF, PREPARE SOIL, FOR NEW CONCRET.

 2. (E) CONVECTION OVER 1TO BE REMOVED BY OWNER.

 3. (E) KITCHES INSKY TO REMAN.

 4. (E) HAND WASH SINK TO REWAN.

 5. (E) KITCHES COUPPERT TO REMAN.

 6. (E) FLOOR SINK TO REWAN.

 7. (E) FLOOR GRANI TO REWAN.

 8. (E) KITCHES COUPPERT TO REMAN.

 8. (E) KITCHES CONCRETE FOR (B) FLOOR SINK, (B) TRENCH DRABIL, AND (B) FIPRIS, PREPARE SOIL, FOR NEW CONCRETE.

GENERAL NOTES

A. FIELD VERIFY SIZE AND LOCATION OF EXISTING LINES PRIOR TO COMMENCEMENT OF WORK



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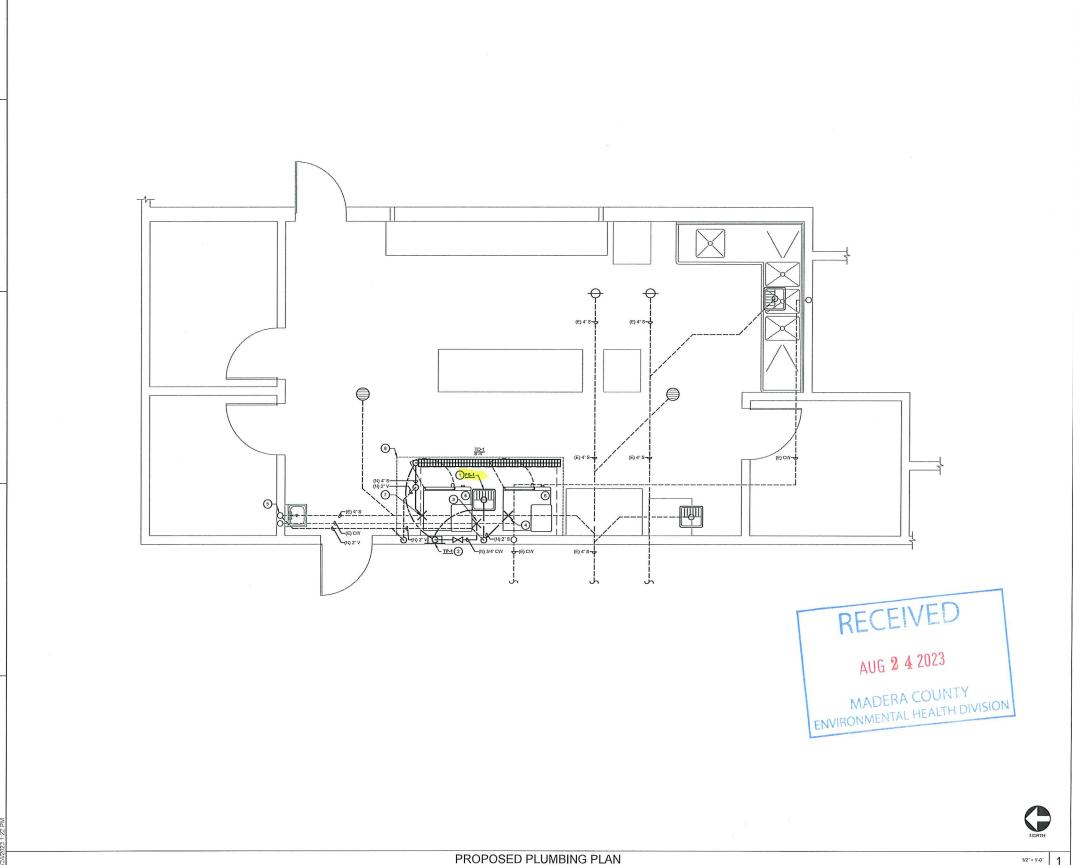
MADERA USD
PARKWOOD ES KITCHEN
11190 EPECAN AND EN CA 202077

DATE: 07/18/2023 SHEET TITLE:

PLUMBING DEMOLITION PLAN

SHEET NO:

P200



KEYNOTES @

- AND VISIBLE FOR HEALTH DEPARTIMENT REFECTION.

 PROVIDE (I) TRAP PRIMER, PROVIDE 121/2" SS ACCESS PANEL.

 PROC OF (I) 3'4" CVI TO (IS CW LINE.

 CONNECT (I) 2" YTO (IS) VEHT ABOVE CELLING.

 (I) OWNER RURISHED ELECTRIC POWERED STEM OVER WITH PROVIDED YOMER (INC.)

 PROVIDED WOMER (INC.)

 PROVIDED WOMER (INC.)

 PROVIDE (I) 4" ST O(IS) 4" S.

 MATCH (I) SLOPE TO (IS) SURFACES, PROVIDE DOWLES @ (II) JOHN.

GENERAL NOTES

FIELD VERIFY SIZE AND LOCATION OF EXISTING LINES PRIOR TO COMMENCEMENT OF WORK



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Symbol	Description				
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MADERA USD PARKWOOD ES KITCHEN

DATE: 07/18/2023 SHEET TITLE: PROPOSED **PLUMBING** PLAN SHEET NO: P201

1/2" = 1'-0"